

| PRC | REV. NO. | DATE | DESCRIPTION | APPROVED BY | DATE OF ISSUE: | 07/02/2025 |
|--------|-------------|----------|-------------------|-------------|----------------|------------|
| TAS | \triangle | 05/03/25 | ISSUED FOR BID | GP | DATE OF 1330E. | |
| \DATAS | \triangle | 07/02/25 | REVISED KEY NOTES | GP | DESIGNED BY: | ANT |
| 1ABQ) | | | | | DRAWN BY: | RT, ANT |
| DATA | | | | | CHECKED BY: | GP |
| - | | | | | APPROVED BY: | GP |







TOWN OF TAOS TAOS COUNTY, NEW MEXICO EDA 08-79-05544 TAOS REGIONAL AIRPORT WATER AND WASTEWATER UTILITIES TAOS COUNTY, NM


PLAN AND PROFILE 12 - SEWER

SHEET 18 OF 34 DWG NO. C-14


JOB NO. DB21.1270

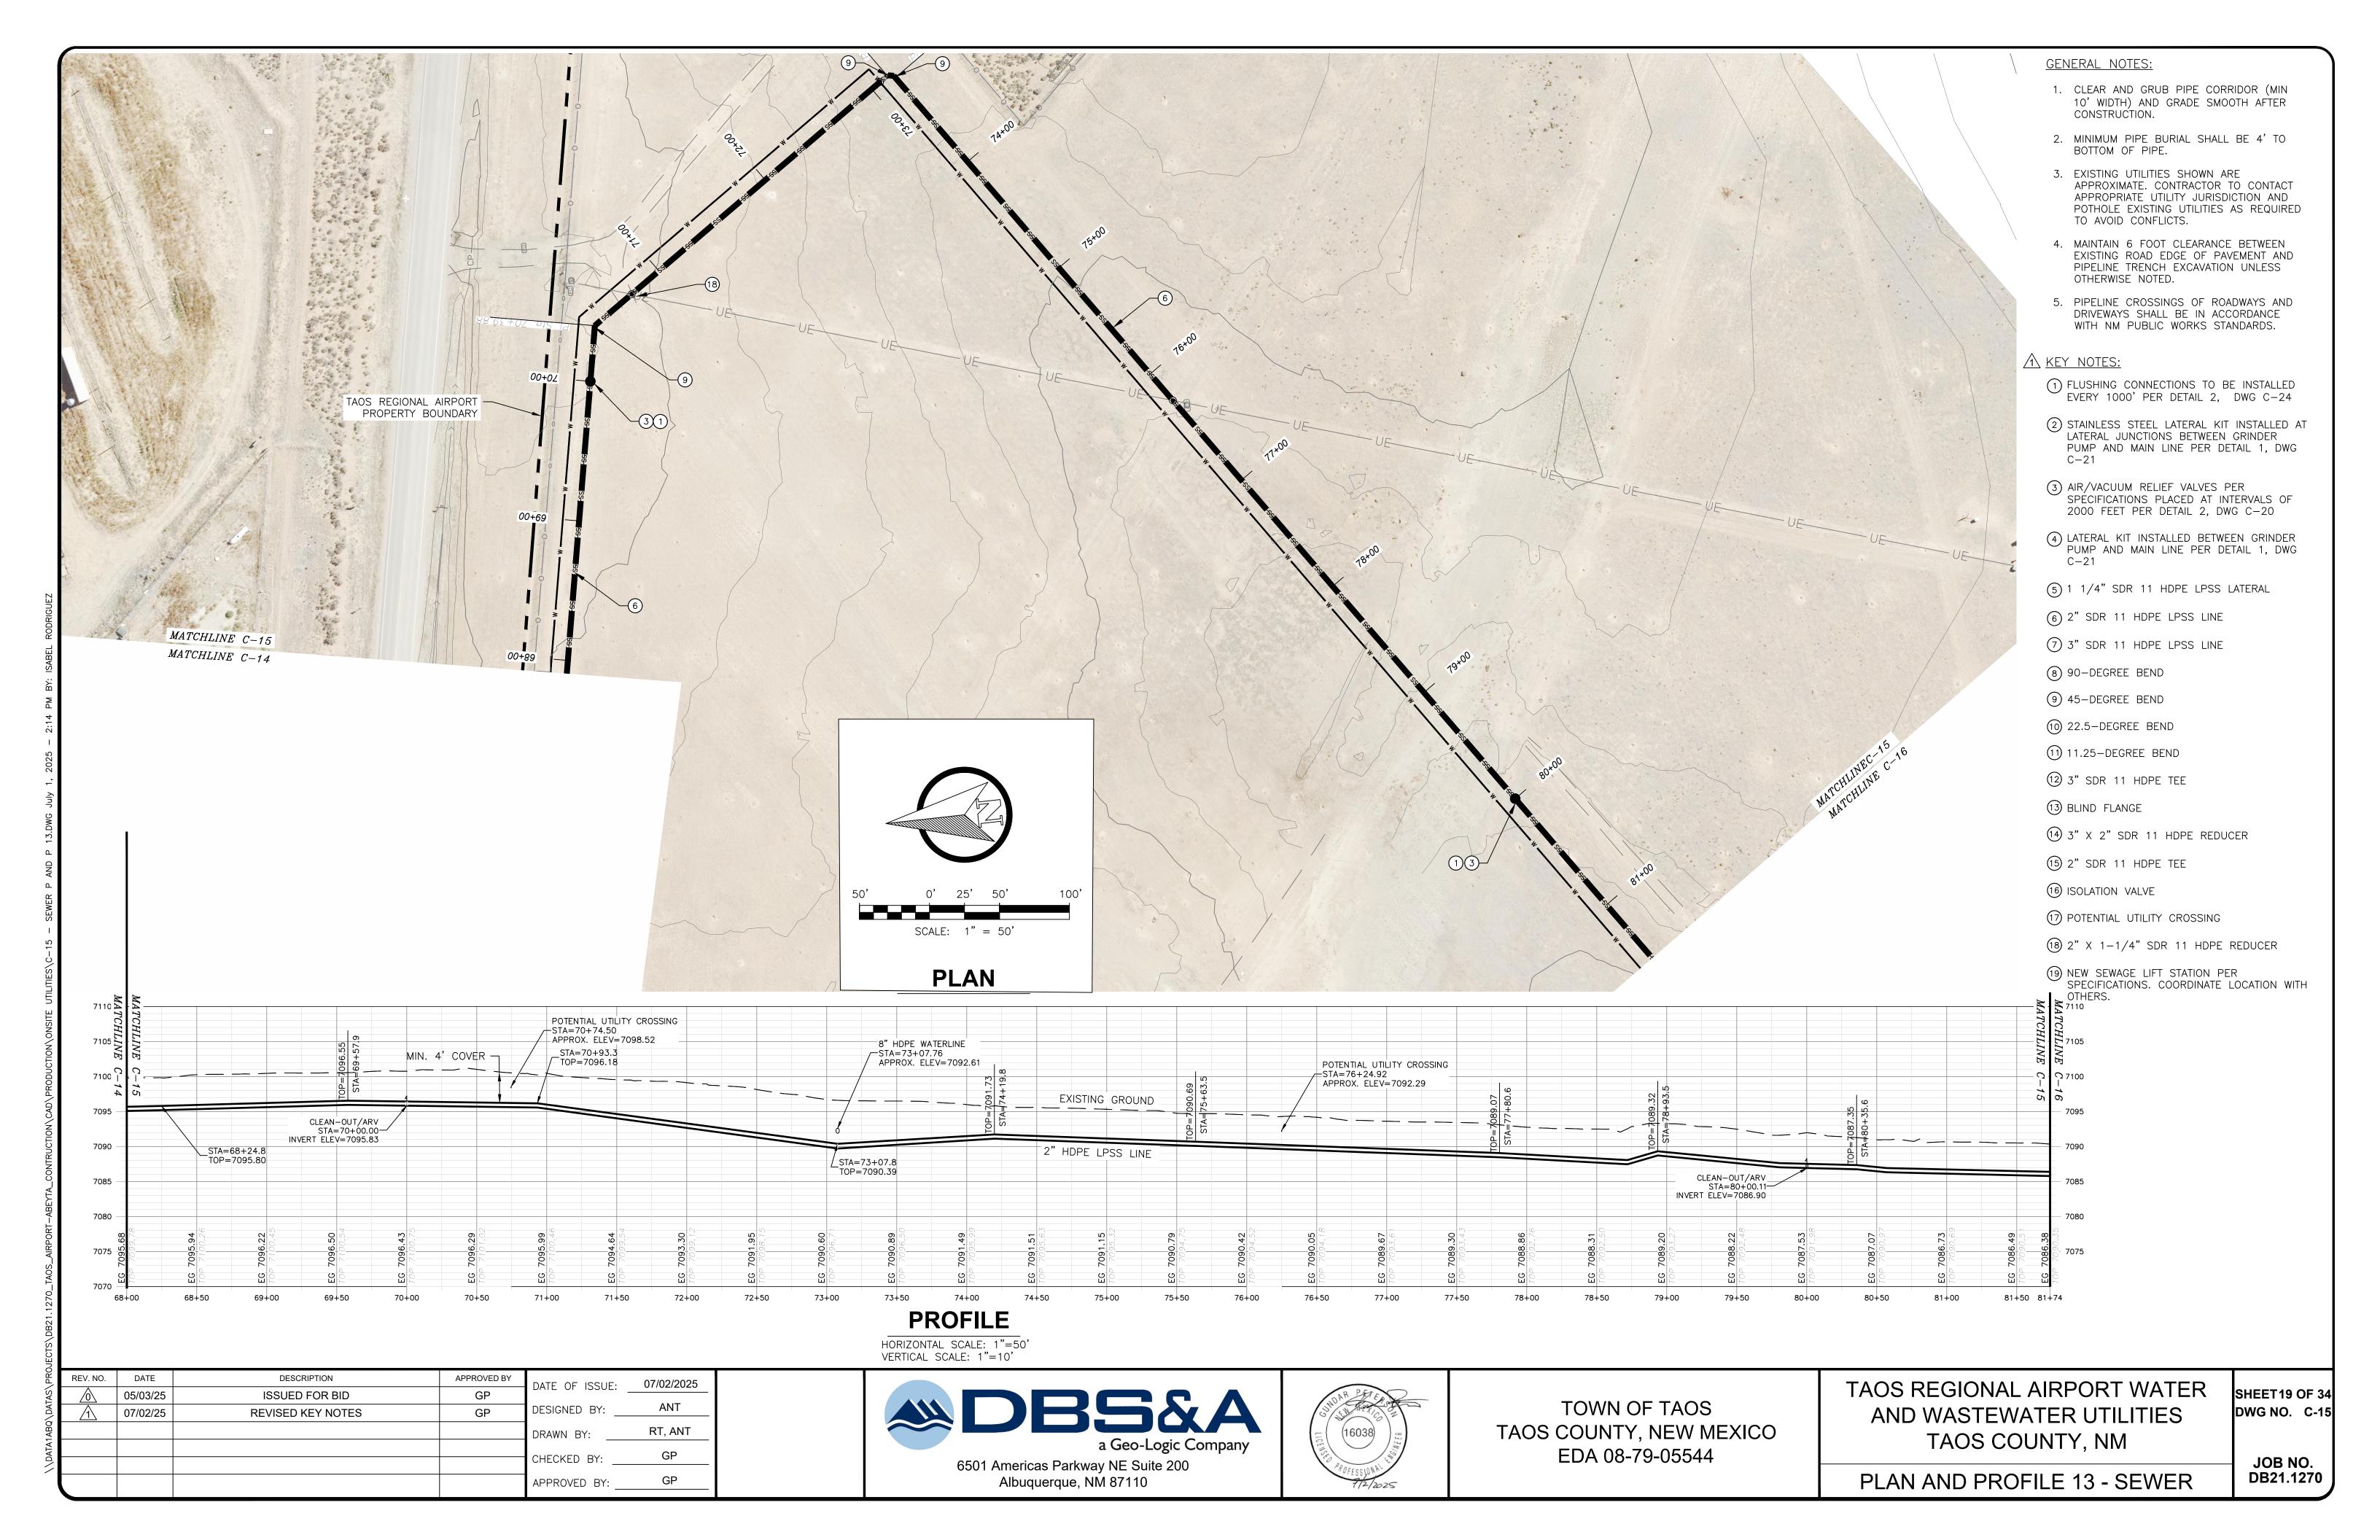

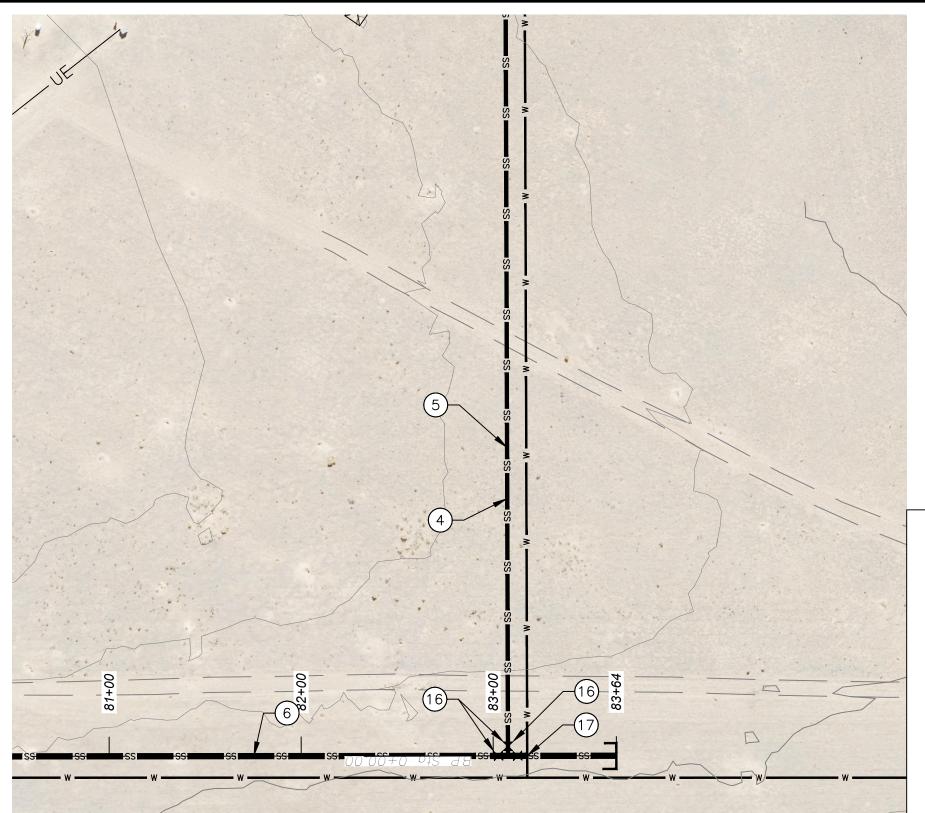

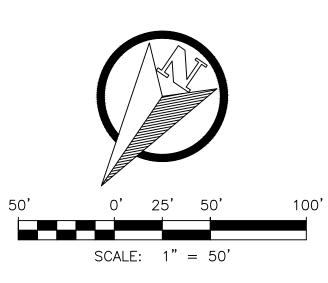

PLAN

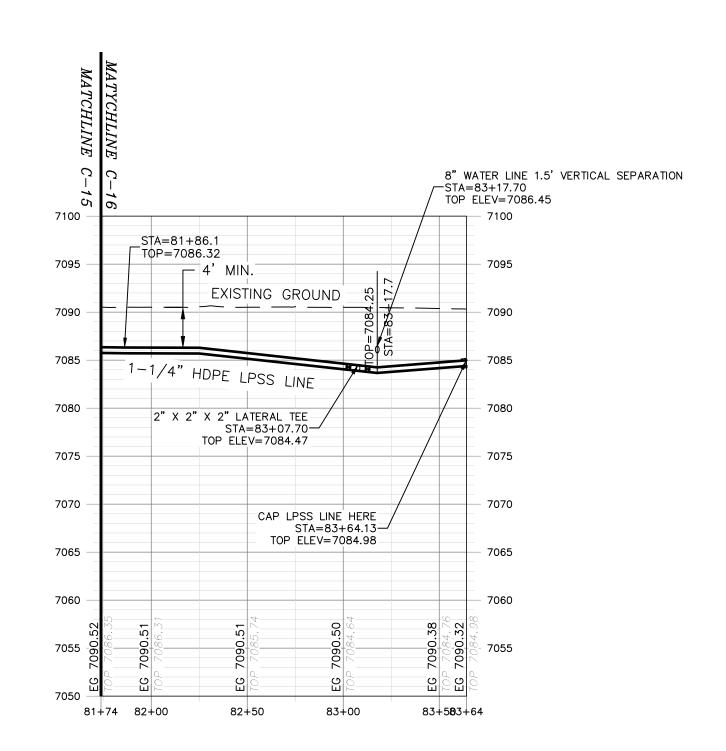

PROFILE

HORIZONTAL SCALE: 1"=50' VERTICAL SCALE: 1"=5'

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TOWN OF TAOS TAOS COUNTY, NEW MEXICO EDA 08-79-05544

TAOS REGIONAL AIRPORT WATER AND WASTEWATER UTILITIES TAOS COUNTY, NM

GENERAL NOTES:

CONSTRUCTION.

BOTTOM OF PIPE.

3. EXISTING UTILITIES SHOWN ARE

TO AVOID CONFLICTS.

OTHERWISE NOTED.

KEY NOTES:

C - 21

C - 21

1. CLEAR AND GRUB PIPE CORRIDOR (MIN 10' WIDTH) AND GRADE SMOOTH AFTER

2. MINIMUM PIPE BURIAL SHALL BE 4' TO

4. MAINTAIN 6 FOOT CLEARANCE BETWEEN EXISTING ROAD EDGE OF PAVEMENT AND PIPELINE TRENCH EXCAVATION UNLESS

5. PIPELINE CROSSINGS OF ROADWAYS AND DRIVEWAYS SHALL BE IN ACCORDANCE WITH NM PUBLIC WORKS STANDARDS.

1) FLUSHING CONNECTIONS TO BE INSTALLED EVERY 1000' PER DETAIL 2, DWG C-24

2 STAINLESS STEEL LATERAL KIT INSTALLED AT LATERAL JUNCTIONS BETWEEN GRINDER PUMP AND MAIN LINE PER DETAIL 1, DWG

SPECIFICATIONS PLACED AT INTERVALS OF 2000 FEET PER DETAIL 2, DWG C-20

4 LATERAL KIT INSTALLED BETWEEN GRINDER PUMP AND MAIN LINE PER DETAIL 1, DWG

(5) 1 1/4" SDR 11 HDPE LPSS LATERAL

(6) 2" SDR 11 HDPE LPSS LINE

7 3" SDR 11 HDPE LPSS LINE

8 90-DEGREE BEND

9 45-DEGREE BEND

(10) 22.5-DEGREE BEND

(1) 11.25-DEGREE BEND

① 3" SDR 11 HDPE TEE

15) 2" SDR 11 HDPE TEE

(17) POTENTIAL UTILITY CROSSING

(18) 2" X 1-1/4" SDR 11 HDPE REDUCER

(19) NEW SEWAGE LIFT STATION PER SPECIFICATIONS. COORDINATE LOCATION WITH OTHERS.

16 ISOLATION VALVE

14 3" X 2" SDR 11 HDPE REDUCER

13 BLIND FLANGE

(3) AIR/VACUUM RELIEF VALVES PER

APPROXIMATE. CONTRACTOR TO CONTACT APPROPRIATE UTILITY JURISDICTION AND POTHOLE EXISTING UTILITIES AS REQUIRED

-IOB NO


SHEET20 OF 34

DWG NO. C-16

JOB NO. DB21.1270



PLAN

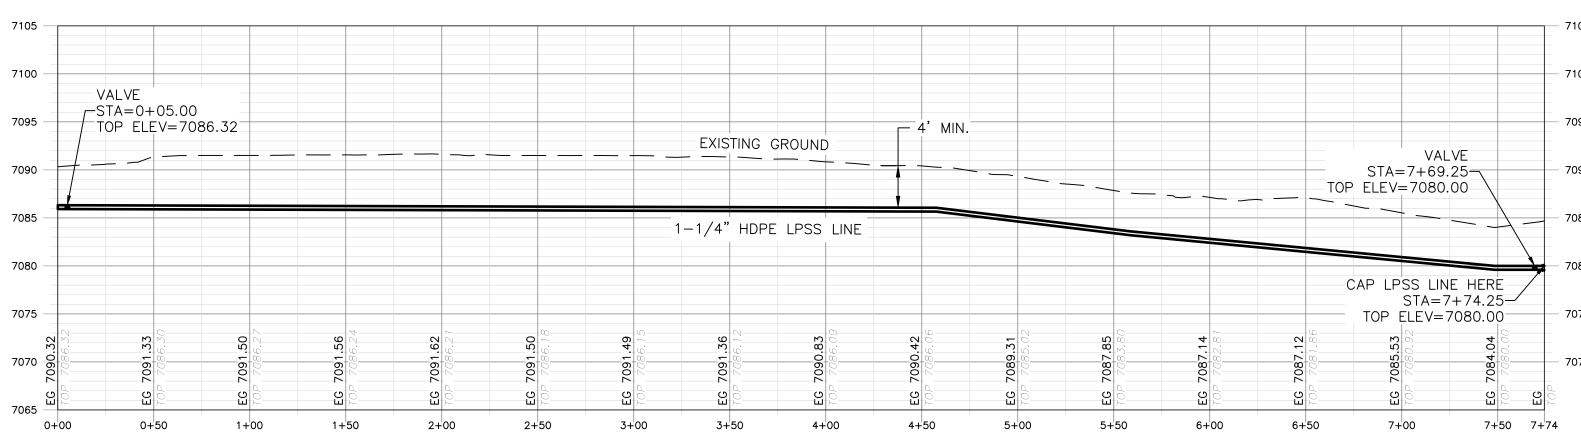

PROFILE

HORIZONTAL SCALE: 1"=50' VERTICAL SCALE: 1"=5'

REV. NO. DATE DESCRIPTION APPROVED BY DATE OF ISSUE: ___07/02/2025 GP ISSUED FOR BID 05/03/25 ANT DESIGNED BY: GP 07/02/25 SHEET ADDED RT, ANT DRAWN BY: CHECKED BY: APPROVED BY: __





TOWN OF TAOS TAOS COUNTY, NEW MEXICO

SCALE: 1" = 50'

TAOS REGIONAL AIRPORT WATER AND WASTEWATER UTILITIES TAOS COUNTY, NM

DWG NO. C-16A

SHEET21 OF 34

JOB NO. DB21.1270

EDA 08-79-05544

(19) NEW SEWAGE LIFT STATION PER SPECIFICATIONS. COORDINATE LOCATION WITH OTHERS.

(18) 2" X 1-1/4" SDR 11 HDPE REDUCER

(14) 3" X 2" SDR 11 HDPE REDUCER

GENERAL NOTES:

CONSTRUCTION.

BOTTOM OF PIPE.

3. EXISTING UTILITIES SHOWN ARE

TO AVOID CONFLICTS.

OTHERWISE NOTED.

KEY NOTES:

C - 21

C - 21

1. CLEAR AND GRUB PIPE CORRIDOR (MIN 10' WIDTH) AND GRADE SMOOTH AFTER

2. MINIMUM PIPE BURIAL SHALL BE 4' TO

4. MAINTAIN 6 FOOT CLEARANCE BETWEEN

5. PIPELINE CROSSINGS OF ROADWAYS AND DRIVEWAYS SHALL BE IN ACCORDANCE WITH NM PUBLIC WORKS STANDARDS.

1) FLUSHING CONNECTIONS TO BE INSTALLED EVERY 1000' PER DETAIL 2, DWG C-24

2 STAINLESS STEEL LATERAL KIT INSTALLED AT LATERAL JUNCTIONS BETWEEN GRINDER PUMP AND MAIN LINE PER DETAIL 1, DWG

SPECIFICATIONS PLACED AT INTERVALS OF 2000 FEET PER DETAIL 2, DWG C-20

4 LATERAL KIT INSTALLED BETWEEN GRINDER PUMP AND MAIN LINE PER DETAIL 1, DWG

(5) 1 1/4" SDR 11 HDPE LPSS LATERAL

6 2" SDR 11 HDPE LPSS LINE

7 3" SDR 11 HDPE LPSS LINE

8 90-DEGREE BEND

9 45-DEGREE BEND

10 22.5-DEGREE BEND

11 11.25-DEGREE BEND

12 3" SDR 11 HDPE TEE

(15) 2" SDR 11 HDPE TEE

17) POTENTIAL UTILITY CROSSING


16 ISOLATION VALVE

13 BLIND FLANGE

(3) AIR/VACUUM RELIEF VALVES PER

APPROXIMATE. CONTRACTOR TO CONTACT APPROPRIATE UTILITY JURISDICTION AND POTHOLE EXISTING UTILITIES AS REQUIRED

EXISTING ROAD EDGE OF PAVEMENT AND PIPELINE TRENCH EXCAVATION UNLESS

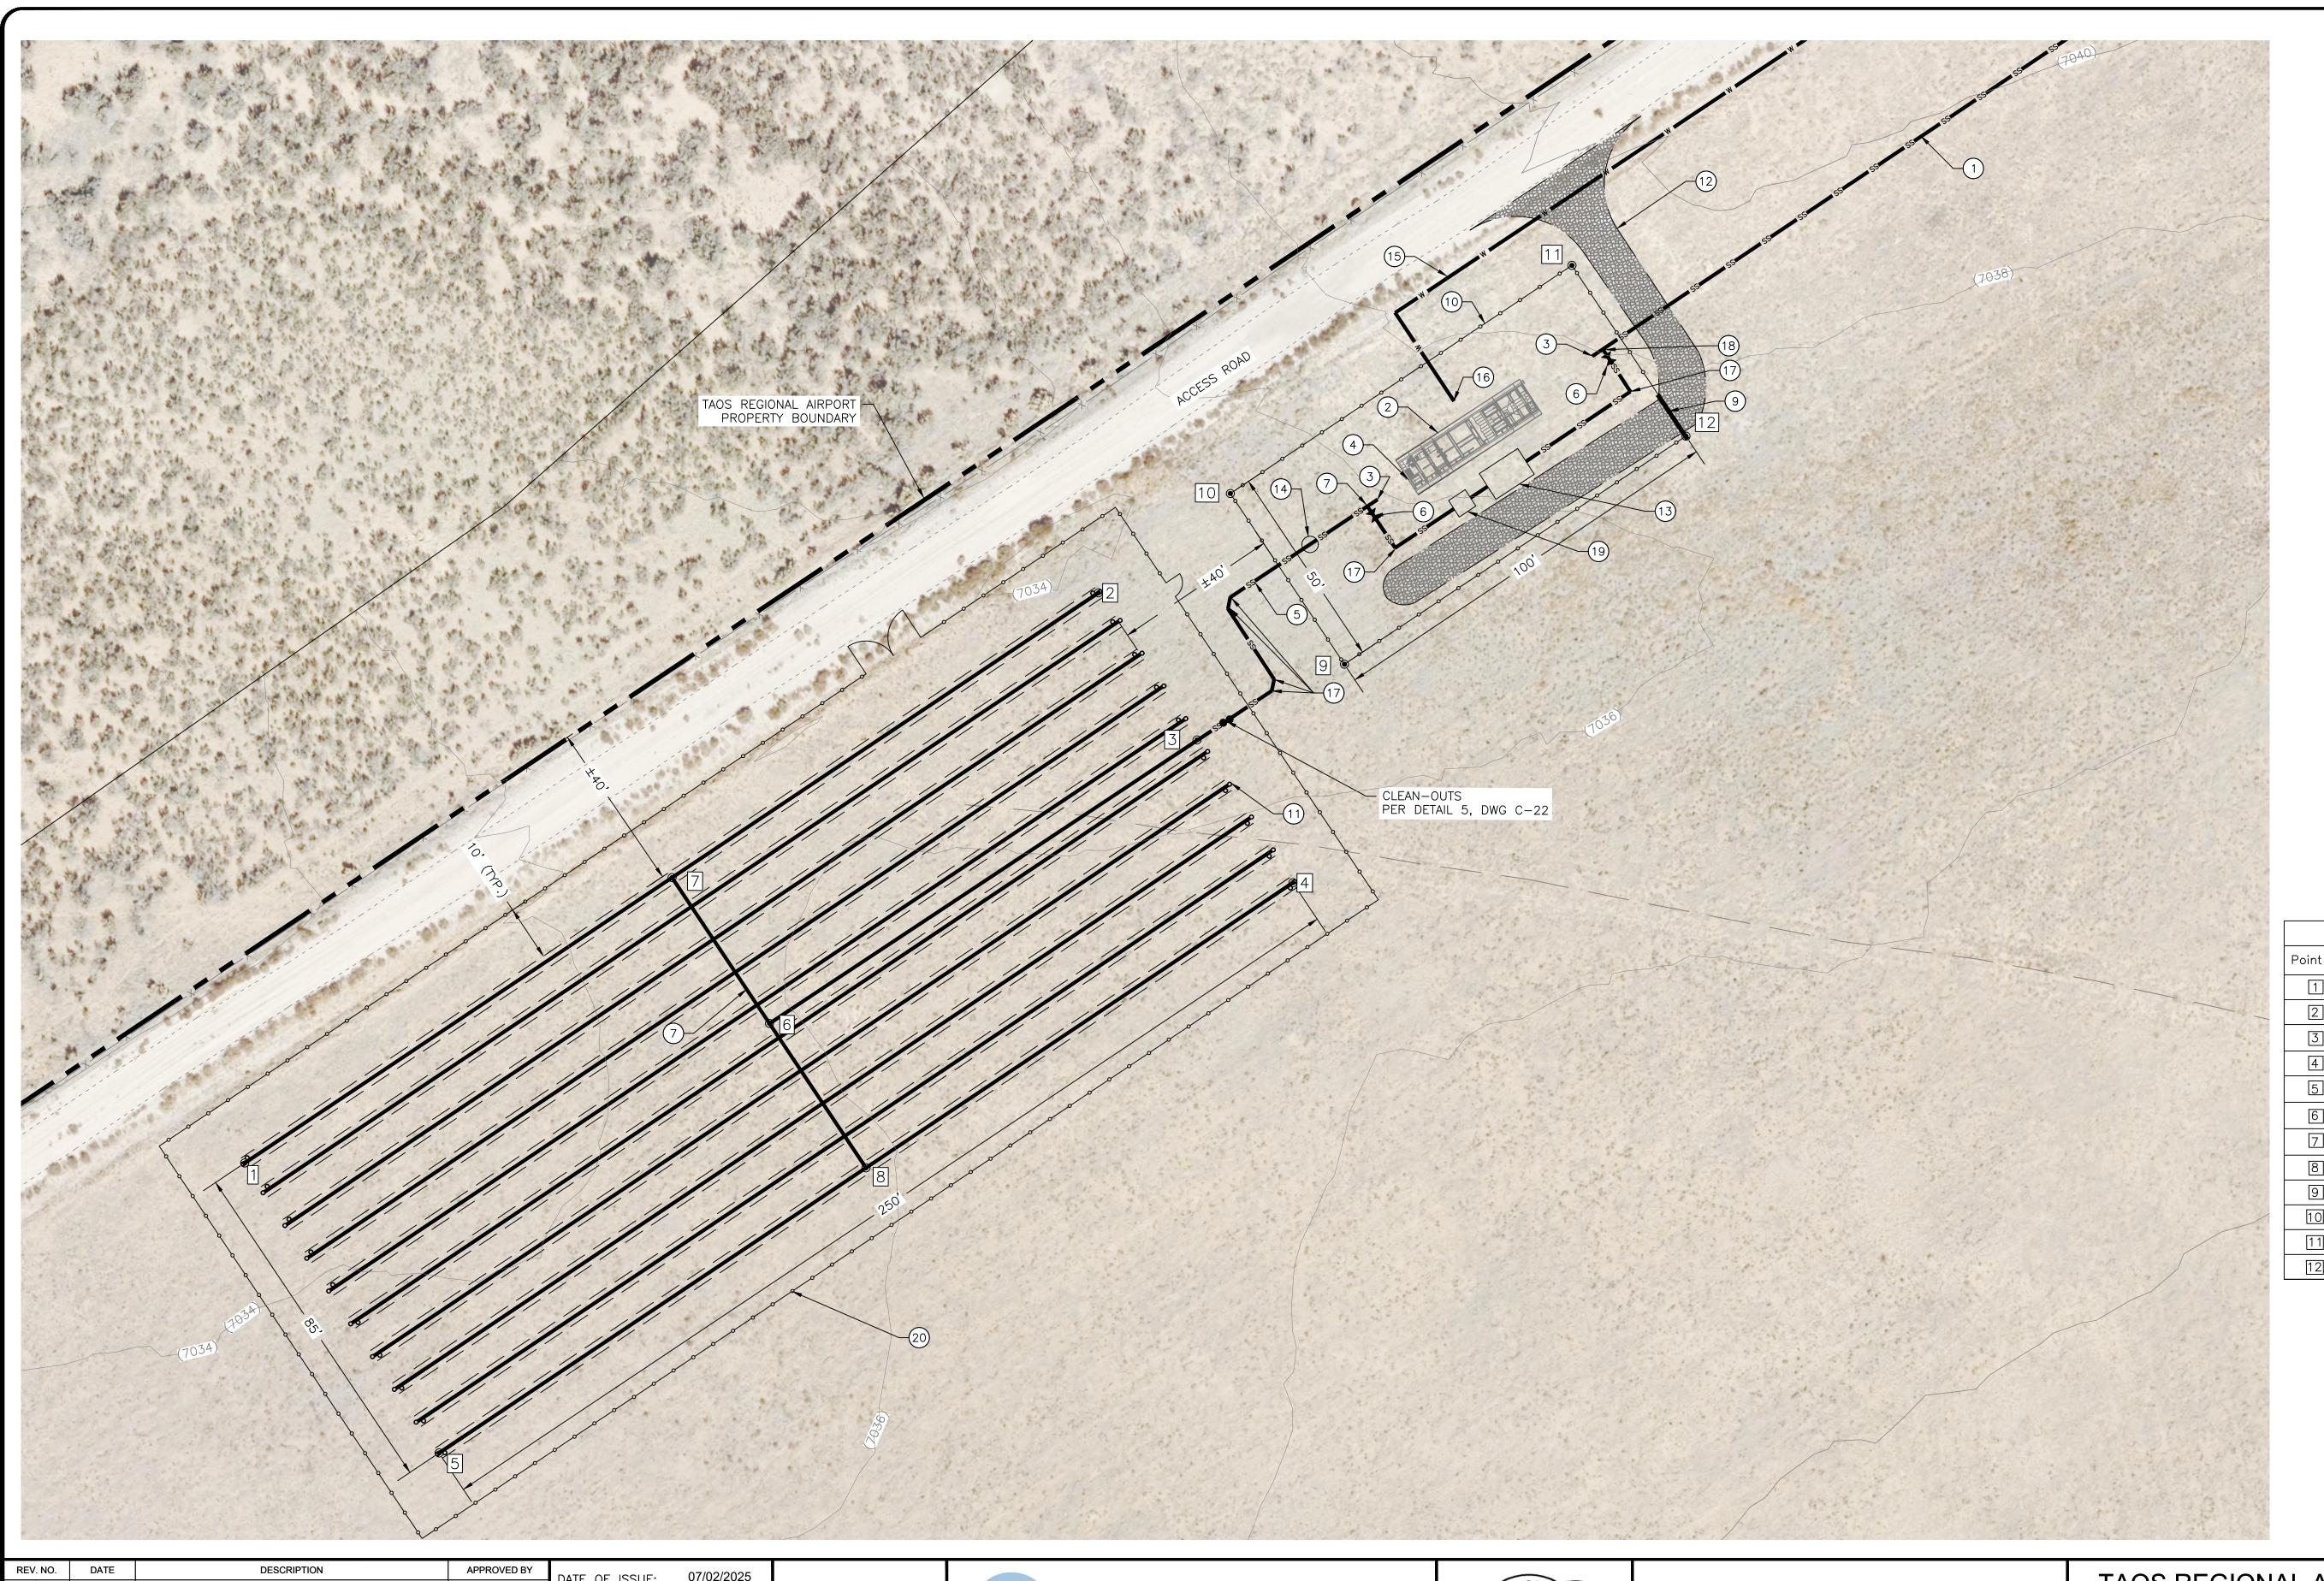

GENERAL NOTES:


1. MINIMUM BURIAL SHALL BE 3' TO TOP OF

- 1) 3" SDR 11 HDPE LPSS LINE
- 2) 10,000 GPD EXTENDED AERATION WWTP PER DETAIL 1, DWG C-24. <u>FUTURE (BY OTHERS)</u>
- 3 STUB OUT 5 FT. MIN AND CAP FOR FUTURE CONNECTION TO WWTP
- (4) 6" BLIND FLANGE OUTLET PIPE CONNECTION REDUCED AND CONNECT TO EFFLUENT PIPE
- 5 2" PVC EFFLUENT PIPE TO LEACH FIELD
- 6 GATE VALVE
- 7 2" PVC TEE
- 8 1-1/4" PVC PERF. DISTRIBUTION PIPE WITH 1/8" ORIFICES.
- 9 VEHICLE GATE AS PER DETAILS 1 AND 2, DWG C-19
- (10) 8' HIGH SECURITY FENCE PER DETAILS 1 AND 2, DWG. C-19
- (1) LEACH FIELD AS PER DETAIL 1, DWG C-22
- (12) GRADE AND COMPACT ROAD AND PROVIDE 3" AGGREGATE BASE COURSE, 16' WIDE
- (13) SEPTIC TANK, PER DETAIL 3 AND 4, DWG.
- (14) FLOW METER IN VAULT PER DETAIL 5, DRAWING C-23
- 15 1" HDPE WATER LINE
- 16 YARD HYDRANT PER DETAIL 3, DWG C-19
- 17) 45 DEG ELBOW
- 18 3" HDPE TEE

C-23

- 19 EFFLUENT PUMPING STATION PER DETAILS 2, DWG C-23
- © FENCE, 4' MAN GATE AND 18' VEHICLE GATE PER DETAIL 2, DWG-18

| | Point Table | | | | |
|---|-------------|------------|------------|-------------------|--|
| | Point # | Northing | Easting | Description | |
| | 1 | 1986758.21 | 1807319.32 | LEACH FIELD | |
| | 2 | 1986898.33 | 1807526.37 | LEACH FIELD | |
| | 3 | 1986862.64 | 1807550.55 | 2" SCH 40 PVC | |
| | 4 | 1986828.01 | 1807574.12 | LEACH FIELD | |
| | 5 | 1986687.90 | 1807367.08 | 2" SCH 40 PVC | |
| | 6 | 1986792.98 | 1807446.90 | 2" SCH 40 PVC TEE | |
| | 7 | 1986828.35 | 1807422.96 | 2" SCH 40 PVC | |
| | 8 | 1986757.96 | 1807470.60 | LEACH FIELD | |
| | 9 | 1986867.41 | 1807583.67 | FENCE CORNER | |
| | 10 | 1986908.82 | 1807555.65 | FENCE CORNER | |
| | 11 | 1986964.86 | 1807638.47 | FENCE CORNER | |
| | 12 | 1986923.45 | 1807666.49 | FENCE CORNER | |
| - | | | | Δ. | |

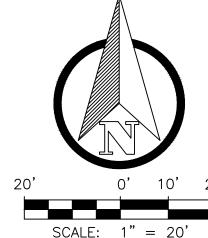

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a Geo-Logic Company 6501 Americas Parkway NE Suite 200 Albuquerque, NM 87110




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WWTP & LEACH FIELD SITE PLAN

SHEET22 OF 34 DWG NO. C-17

> JOB NO. DB21.1270

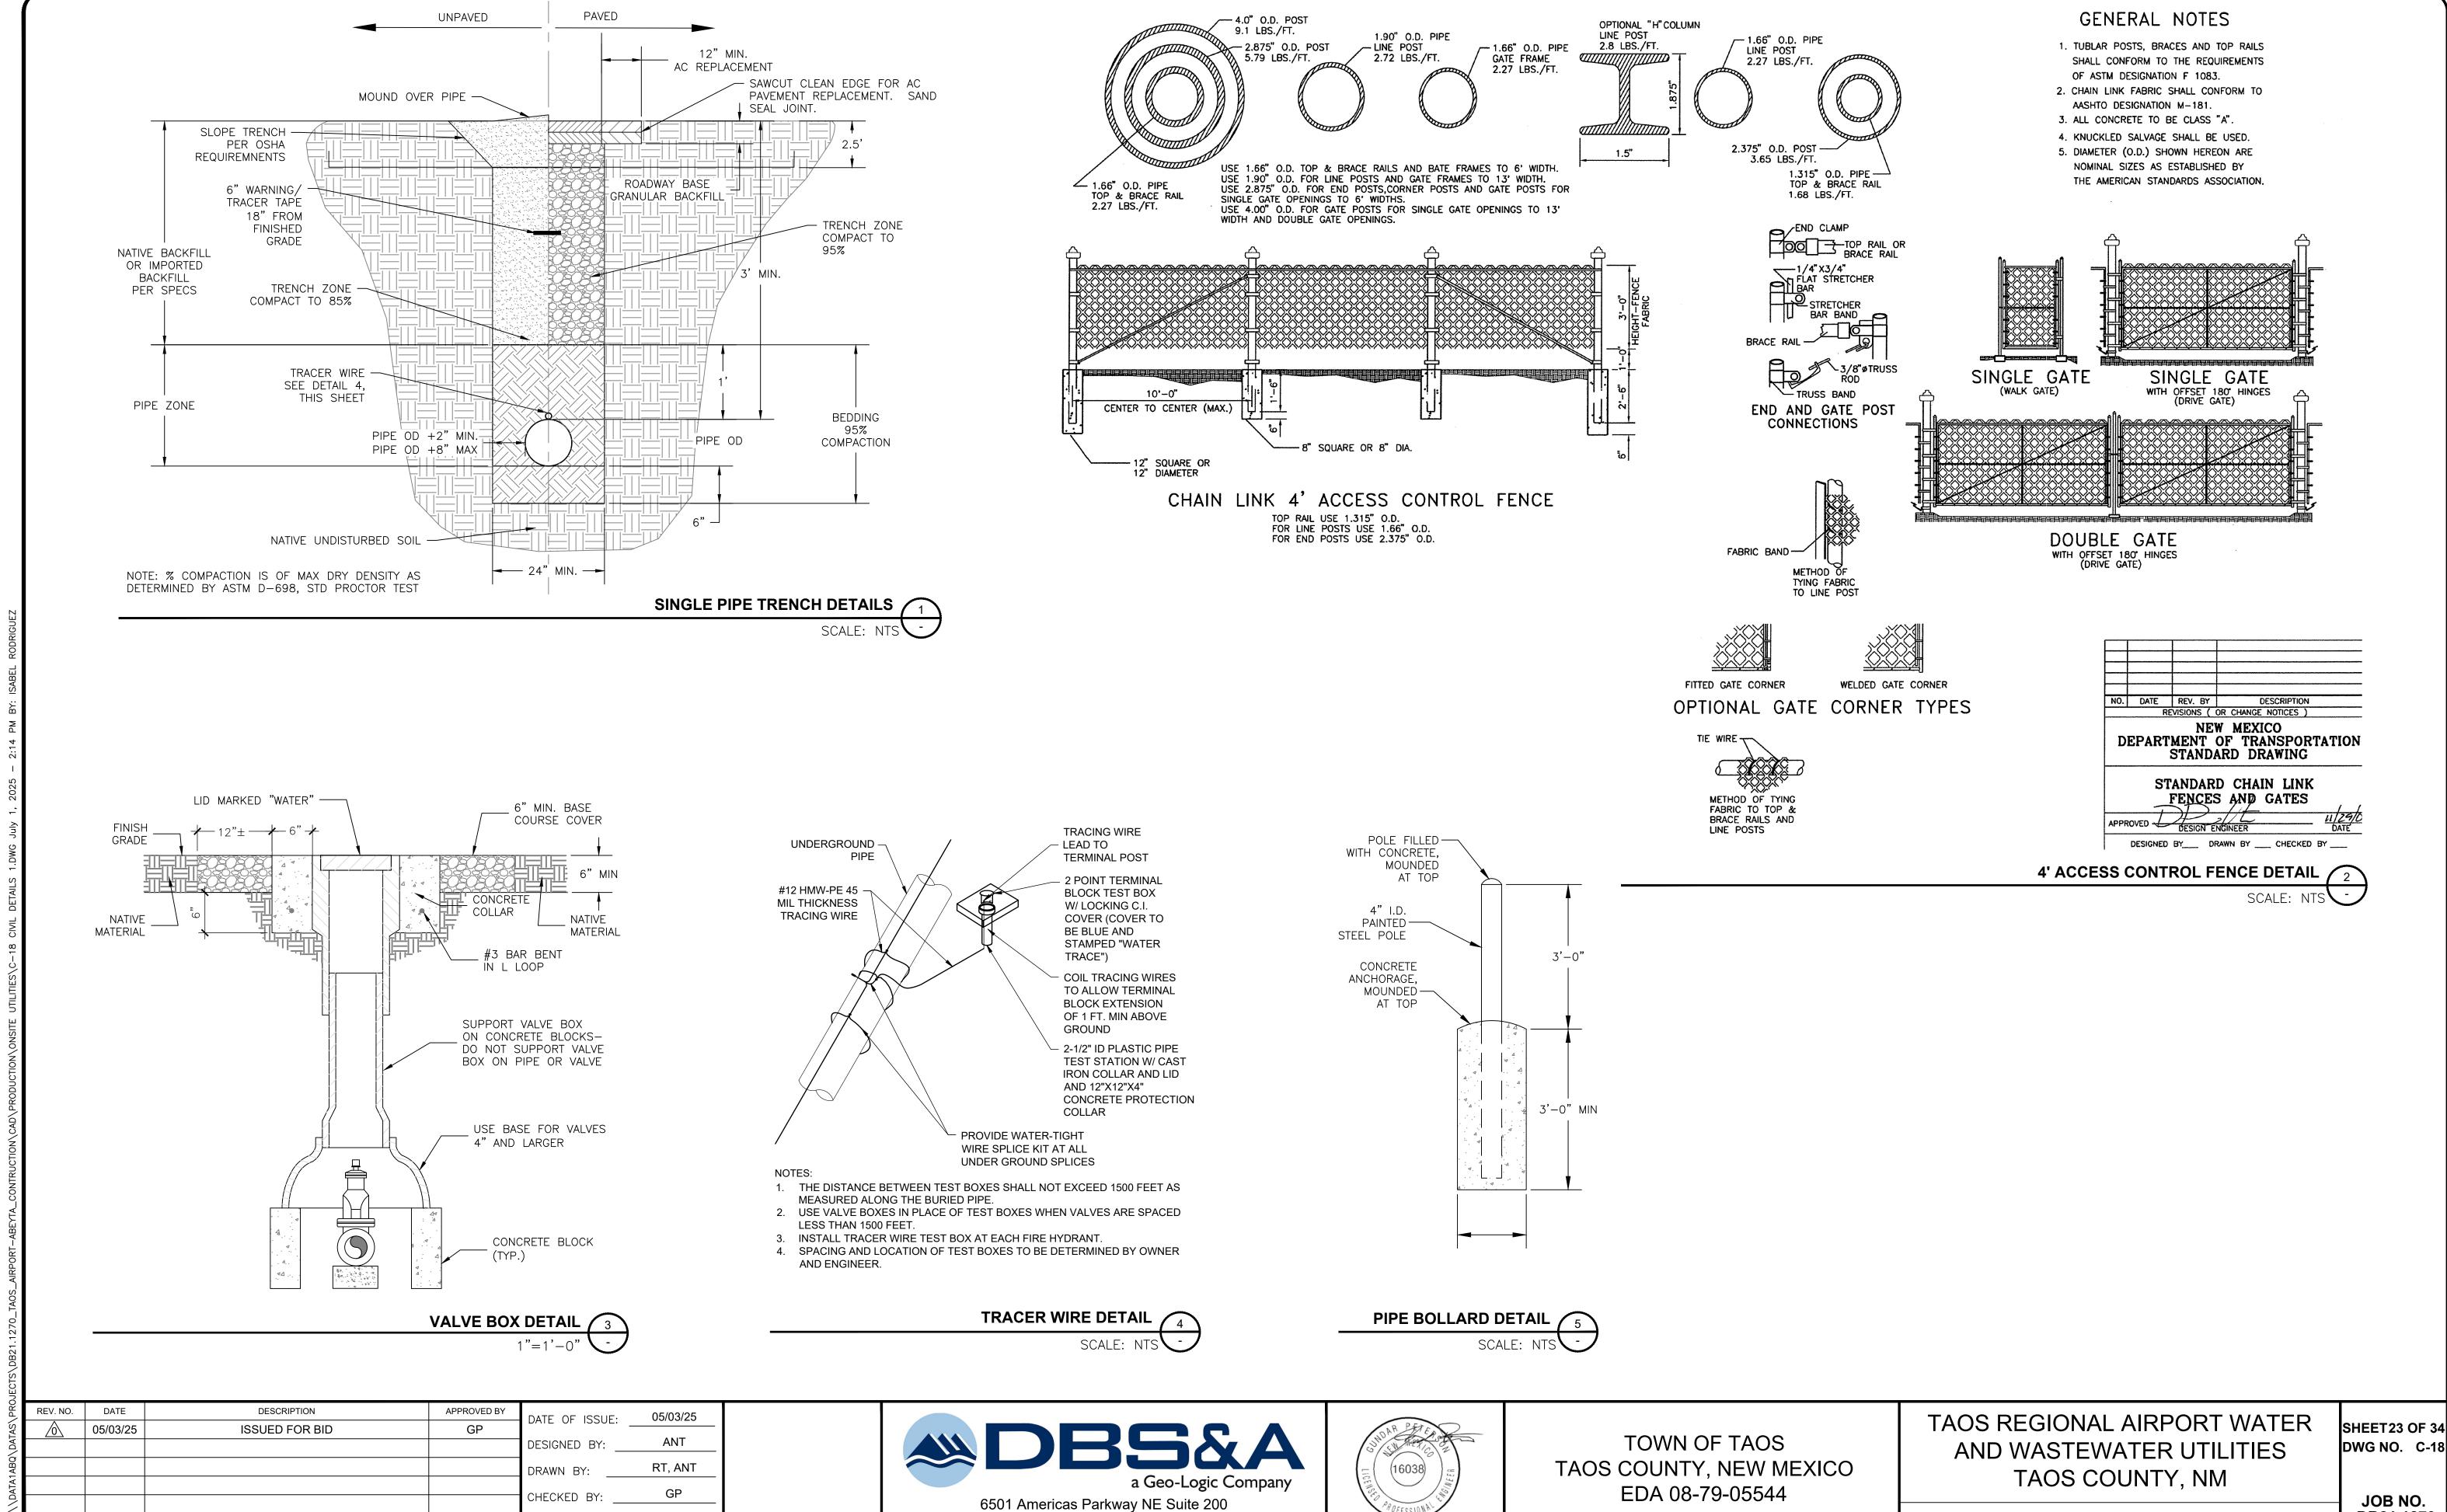

Albuquerque, NM 87110

APPROVED BY:

DB21.1270

CIVIL DETAILS 1